# Merrylands Site C 228 Pitt Street Merrylands NSW 2160

Section 4.55 Landscape Drawings

# **DRAWINGS**

DWG NO.	DRAWING TITLE	SCALE	ISSUE
000	COVER SHEET / PLANT SCHEDULE		E
C100 100	LANDSCAPE COLOUR PLAN - Composite  LANDSCAPE PLAN - Composite	1:200 1:200	E E
101 102	LANDSCAPE PLAN - Ground Floor Central Courtyard LANDSCAPE PLAN - Building B Level 10 Roof Terrace	1:100	E
103	& Building C Level 4 Roof Terrace LANDSCAPE PLAN - Building A Level 20 Roof Terrace	1:100 1:100	E E
401.1 401 402	LANDSCAPE PLANTING PLAN - Streetscape LANDSCAPE PLANTING PLAN - Ground Floor Central Courtyard LANDSCAPE PLANTING PLAN - Building B Level 10 Roof Terrace	1:200 1:100	E E
403	& Building C Level 4 Roof Terrace  LANDSCAPE PLANTING PLAN - Building A Level 20 Roof Terrace	1:100 1:100	E E
501	LANDSCAPE DETAILS / SPECIFICATION	AS SHOWN	Е

LEGEND

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PH RS 13.09.2022 Levels updated Council RFI updated planting labels, soil depth PH RS 07.09.2022 OSD, Pits Location updated PH RS 01.06.2022 B S4.55 PH RS 18.05.2022 PH RS 20.04.2022 A \$4.55 Issue Revision Description Drawn Check Date

**PLANT SCHEDULE** 

Symbol Botanic Name

Trees

Acer palmatum

Corymbia maculata

Elaeocarpus reticulatus

Jacaranda mimosifolia

Platanus x acerifolia

Melaleuca decora

Shrubs

Tristaniopsis laurina

Abelia X grandiflora

Dodonea viscosa

Lavandula dentata

Murraya paniculata

Syzygium Cascade

Westringia fruticosa

**BGW** Blue Gem™ Westringia 'WES03'

Asplenium australasicum

**Grasses and Groudcovers** 

Carpbrotus glaucescens

STT Syzygium Tiny Trev

**Vt** *Viburnum tinus* 

Accents

Agave attenuata

Blechnum gibbum

Cycas revoluta

Strelitzia reginae

Clivia miniata

Dianella caerulea

Lomandra 'Nyalla'

Lomandra 'Tanika'

Poa 'Eskdale'

Vinca minor

Viola hederacea

Hibbertia scandens

Lirope muscari 'Just Right'

Liriope muscari 'Silverlawn'

Muehlenbeckia complexa

Trachelospermum jasminoides

Myoporum parvifolium

Cmi

Rhapis excelsa

Acmena smithii 'Minor'

Buxus microphylla Japonica

Callistemon viminalis Little John

Raphiolepis indica 'Oriental Pearl

Rhapiolepsis indica 'Snow Maiden'

Waterhousea floribunda

Cupaniopsis anacardioides

Lagerstroemia indica 'Natchez"

Magnolia grandiflora Little Gem

SITE IMAGE

Common Name

Japanese Maple

Tuckeroo

Spotted Gum

Blueberry Ash

Crepe Myrtle (White)

London Plane Tree

Little Gem Magnolia

Weeping Lilly Pilly

White Feathered Honeymyrtle

Jacaranda

Water Gum

**Dwarf Lillypilly** 

Japanese Box

French Lavender

Orange Jasmine

Indian Hawthorn

Tiny Trev Lilypilly

Laurestinus

Century Plant

Bird's Nest Fern

**Dwarf Tree Fern** 

Japanese Sago

Bird of Paradise

Pig Face

Kaffir Lily

Paroo Lily

Lirope

Tanika

Wire Vine

Star Jasmine

Native Violet

**Dwarf Periwinkle** 

Snake Vine

Silerlawn Liriope

Nyalla Mat Rush

Creeping Boobialia

Eskdale Tussock Grass

Coastal Rosemary

Rhapis Palm

Hop Bush

Little John Bottlebrush

Oriental Pearl Indian Hawthorn

Pink Flowering Lilly Pilly

Abelia

228 Pitt Street Merrylands NSW 2160

Landscape Coversheet / Plant Schedule

Mature

Width

2.0

2.0

1.2

0.8

1.5

1.0

2.0

2.0

1.0

1.5

0.8

1.5

1.2

2.0

1.0

1.0

1.2

2.0

1.5

0.5

0.6

0.5

0.4

0.65

1.5

0.8

0.5

0.9

Pot Size

100L

300mm

200mm

300mm

300mm

150mm

Quantity

14

17

2

61

42

116

129

12

60

113

24

138

83

136

60

254

40

37

62

17

17

**57** 

14176

66

209

105

249

81

0

146

39

285

48

Height (m)

2.0

2.0

1.2

1.5

4.0

1.0

1.0

2.5

0.8

2.0

1.5

3.0

1.0

1.0

8.0

2.0

1.0

0.2

0.5

0.6

0.6

0.3

0.8

0.6

0.15

0.15

0.8

0.1

0.1

0.15


SECTION 4.55

Scale: Job Number: Drawing Number: SS22-4883 000 E

Landscape Architects Level 1, 3-5 Baptist Street

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Levels updated OSD, Pits Location updated B \$4.55 A S4.55

PH RS 13.09.2022 Council RFI updated planting labels, soil depth PH RS 07.09.2022 PH RS 01.06.2022 PH RS 18.05.2022 PH RS 20.04.2022 Drawn Check Date Issue Revision Description

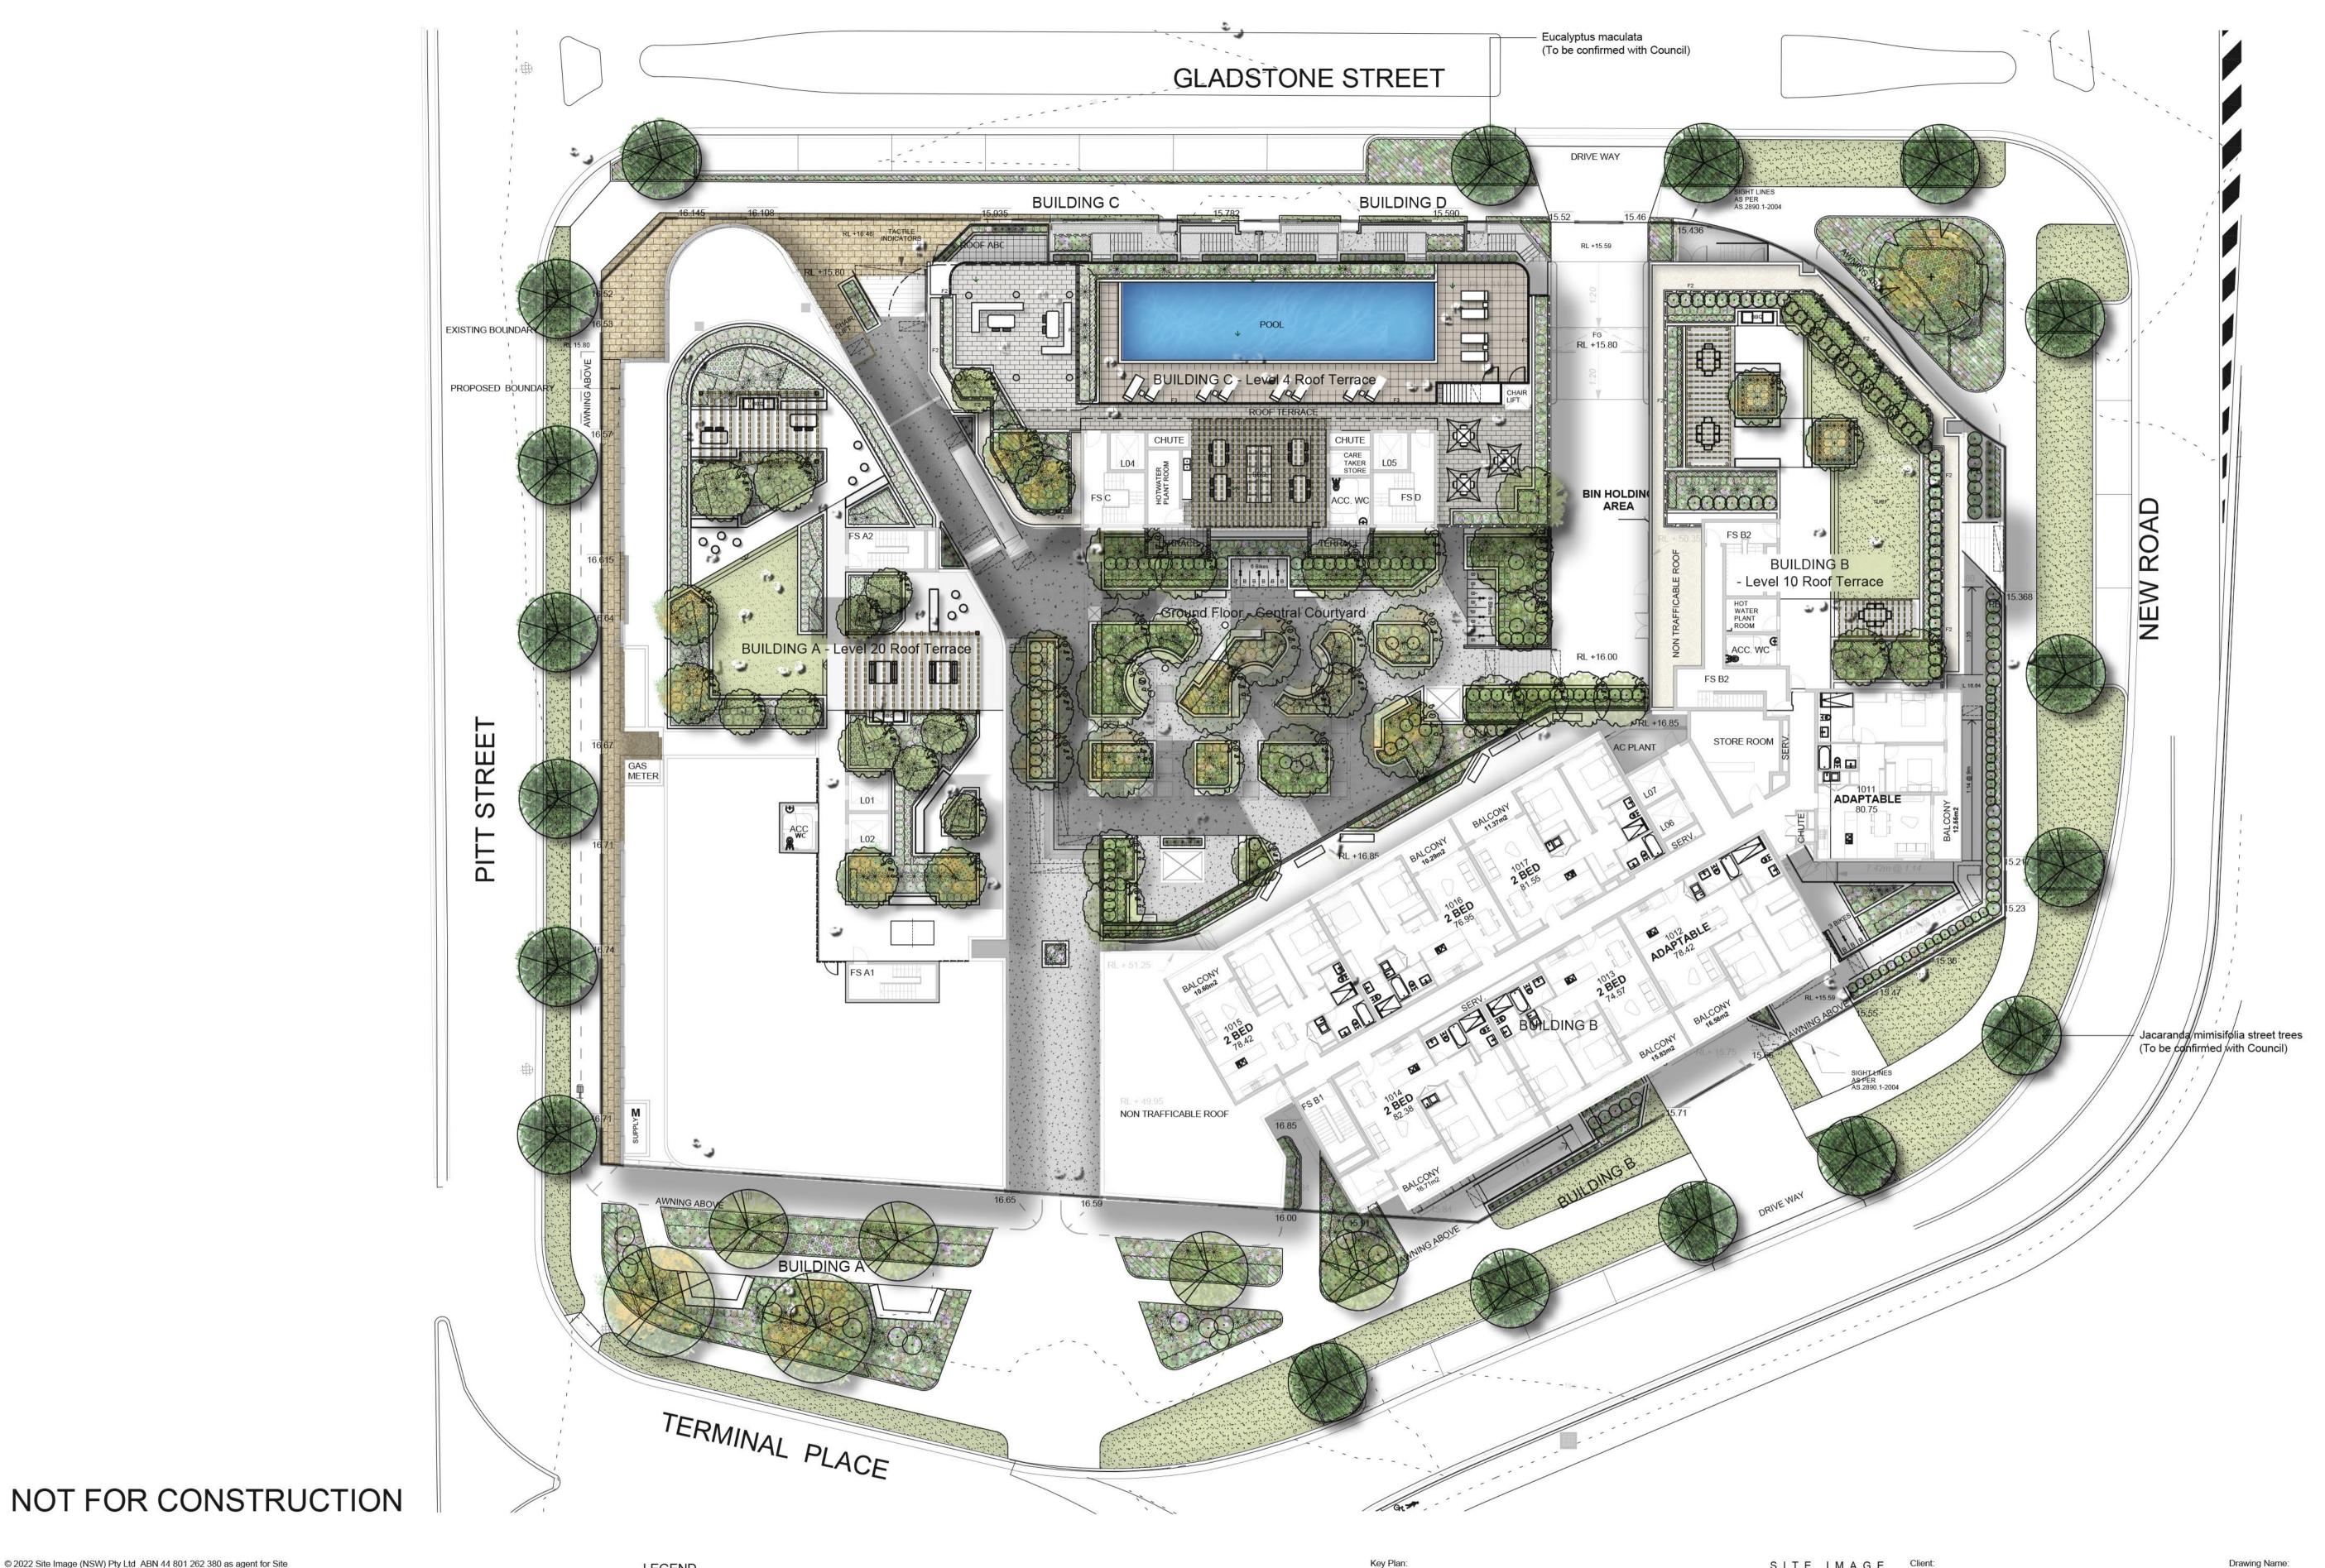**LEGEND** Proposed Trees

Proposed Shrub and Accent BBQ Facilities Sun Loungers

Proposed Massed Grasses and Groundcovers Proposed Turf

Proposed Pergola Structure Concrete Bench Seating

Concrete Unit Paving
Refer Arch. Drawings Concrete Unit Paving Refer Arch. Drawings Decomposed Granite

Proposed Fence Type 1
Refer Details & Specification Proposed Fence Type 2 F2 Refer Details & Specification Proposed Fence Type 3
Refer Details & Specification

Proposed Raised Planter Bed Proposed Soil Depth Proposed Floor level Proposed Top of Bench level Proposed Top of Wall level +TOF Proposed Top of Fence level SITE IMAGE Client:

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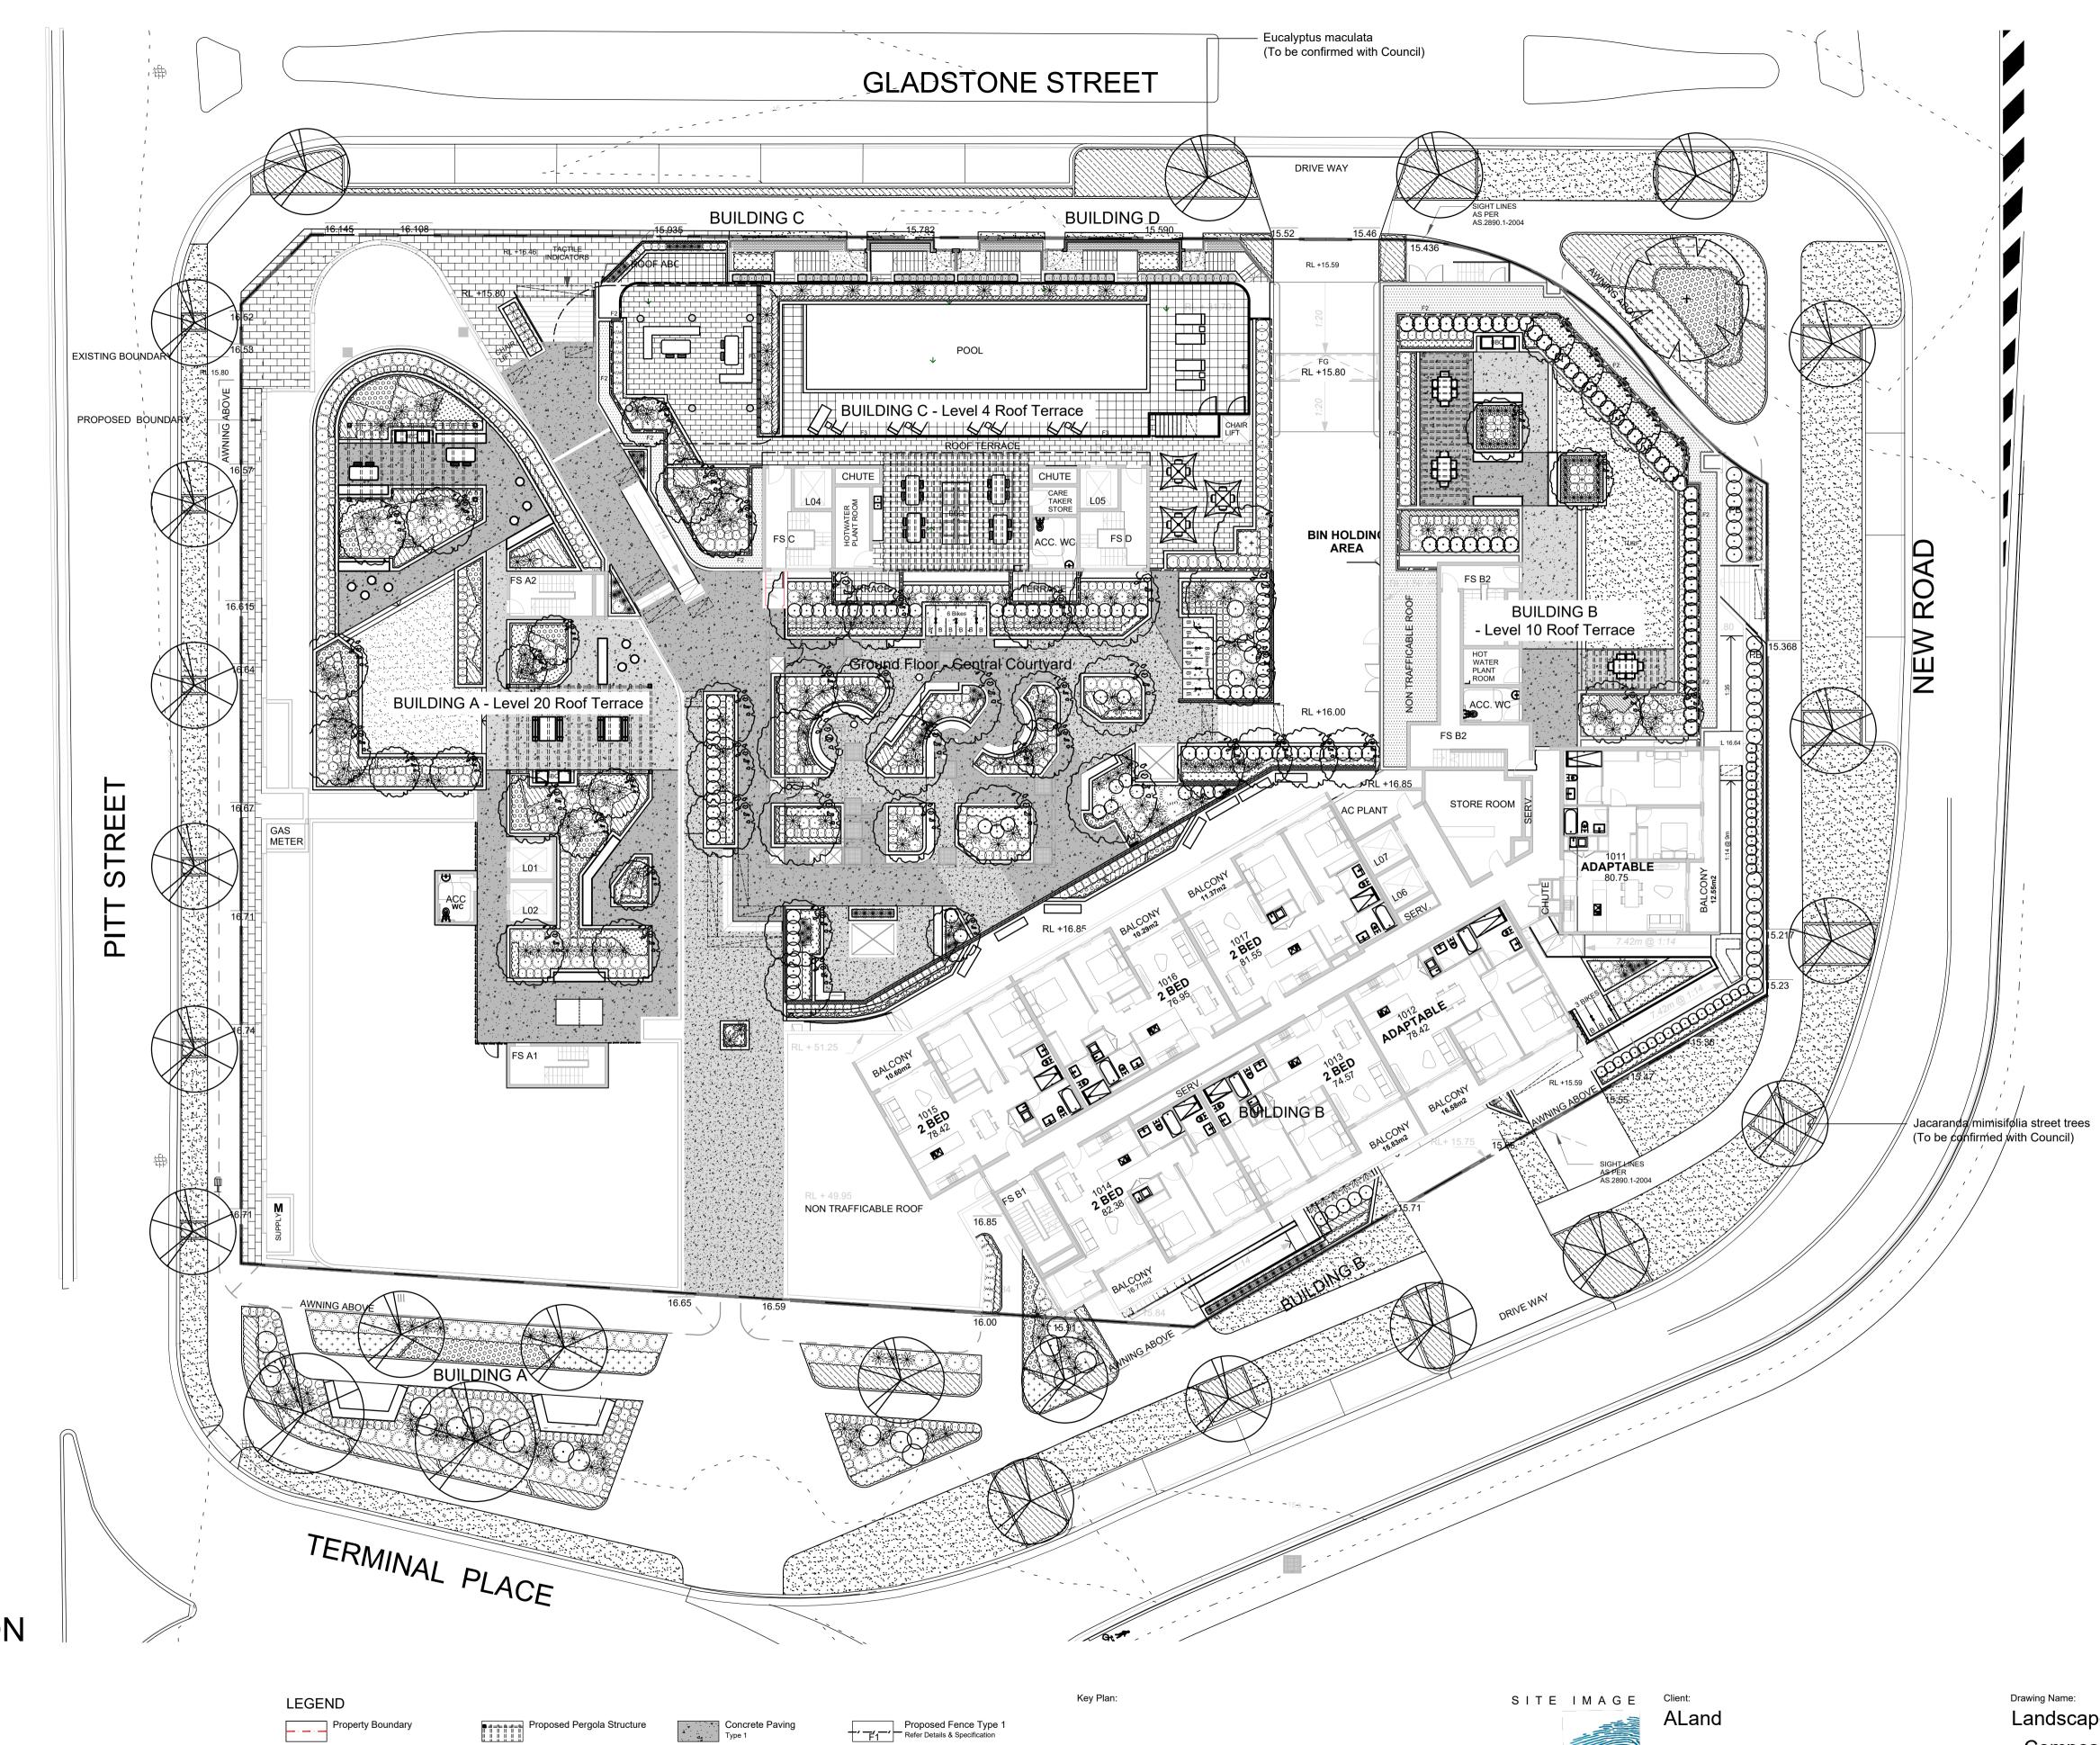
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Landscape Colour Plan - Composite

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Scale: 1:200 @ A1 Job Number: C100 E SS22-4883



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Levels updated OSD, Pits Location updated B S4.55 A \$4.55

Council RFI updated planting labels, soil depth Issue Revision Description

PH RS 13.09.2022 PH RS 07.09.2022 PH RS 01.06.2022 PH RS 18.05.2022 PH RS 20.04.2022 Drawn Check Date

Proposed Shrub and Accent Proposed Massed Grasses and Groundcovers

Proposed Turf

Table & Chairs Concrete Bench Seating BBQ Facilities

Sun Loungers

Concrete Unit Paving
Refer Arch. Drawings Concrete Unit Paving Refer Arch. Drawings Decomposed Granite

Proposed Fence Type 2 F2 Refer Details & Specification Proposed Fence Type 3
Refer Details & Specification ☐ Proposed Raised Planter Bed Proposed Soil Depth Proposed Floor level Proposed Top of Bench level Proposed Top of Wall level

Proposed Top of Fence level

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Landscape Plan - Composite

SECTION 4.55 Scale: 1:200 @ A1

100 E SS22-4883



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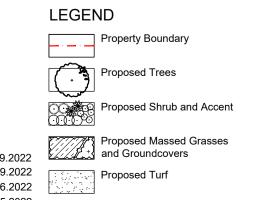
PH RS 13.09.2022 Levels updated Council RFI updated planting labels, soil depth PH RS 07.09.2022 OSD, Pits Location updated PH RS 01.06.2022 B S4.55 PH RS 18.05.2022


PH RS 20.04.2022


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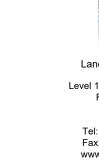
A S4.55

Issue Revision Description





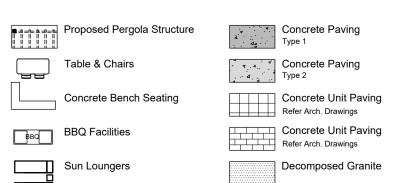


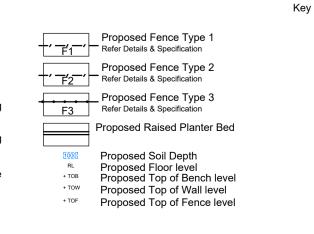

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Drawing Name: Landscape Plan - Ground Floor Central Courtyard

SECTION 4.55 Scale: 1:100 @ A1 101 E SS22-4883



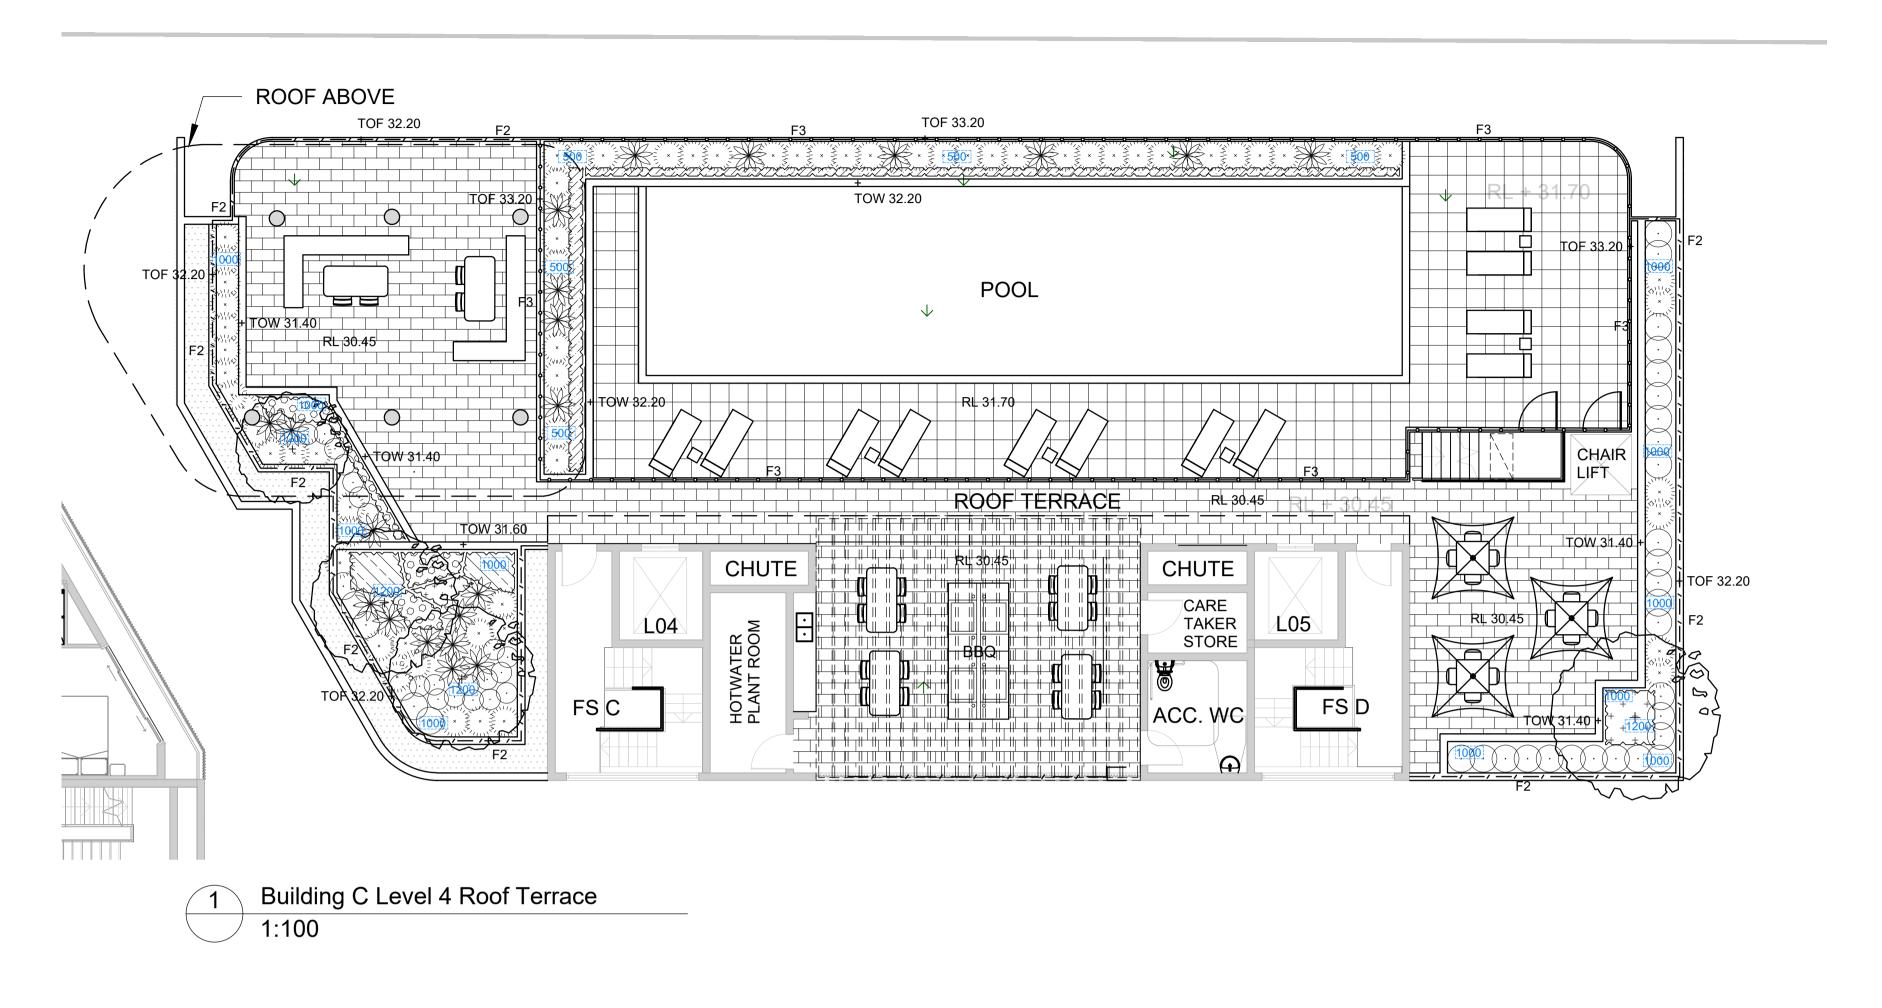

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 E
 Levels updated
 PH
 RS
 13.09.2022


 D
 Council RFI updated planting labels, soil depth
 PH
 RS
 07.09.2022

 C
 Council RFI updated planting labels, soil depth
 PH
 RS
 07.09.2022

 B
 S4.55
 PH
 RS
 18.05.2022


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 S4.55
 PH
 RS
 20.04.2022


 Issue
 Revision Description
 Drawn
 Check
 Date

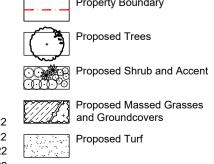



LEGEND



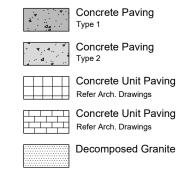

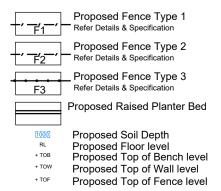

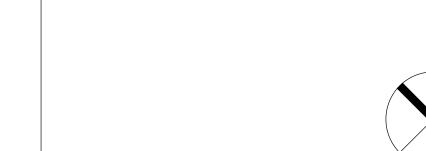

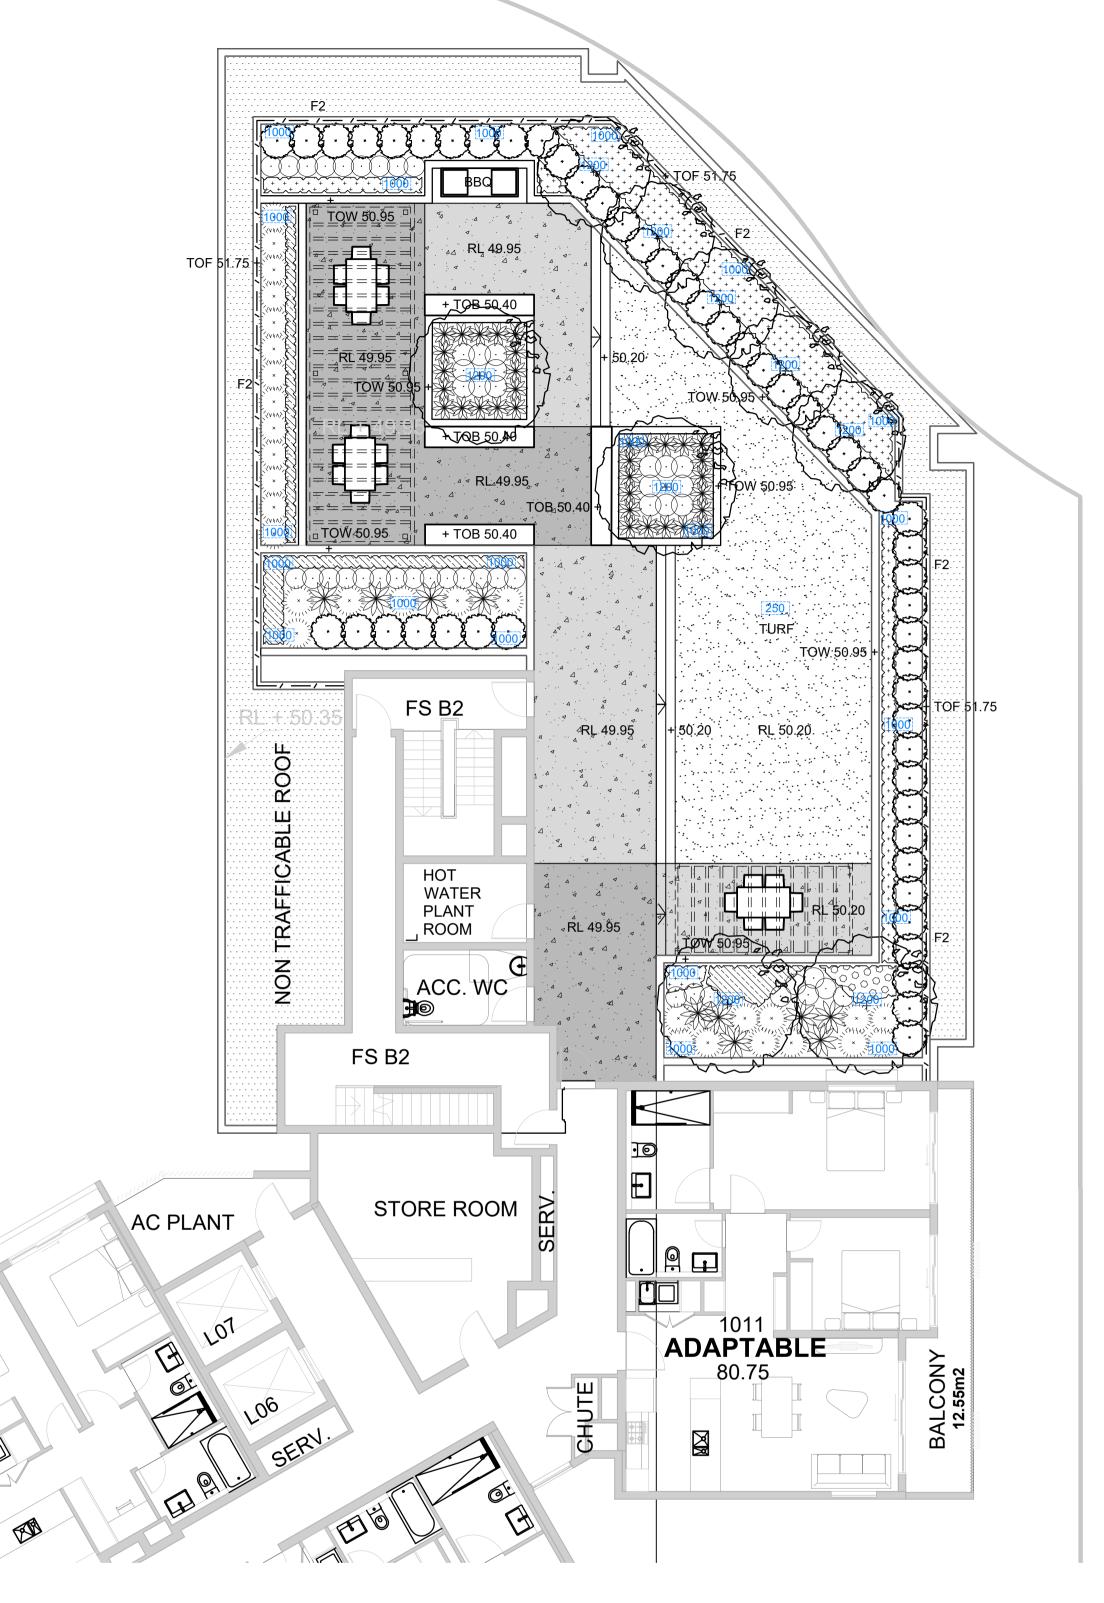

Building B Level 10 Roof Terrace



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Landscape Plan
- Building C Level 4 Roof Terrace
& Building B Level 10 Roof Terrace
SECTION 4.55

# ACC wc ŔL 82₄35 🍕 Building A Level 20 Roof Terrace

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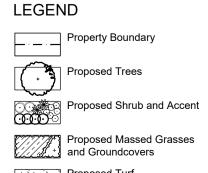
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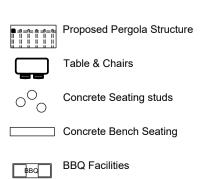
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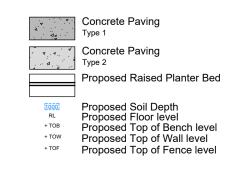
Levels updated Council RFI updated planting labels, soil depth PH RS 07.09.2022 Council RFI updated planting labels, soil depth PH RS 07.09.2022 B \$4.55 A \$4.55

PH RS 13.09.2022 PH RS 18.05.2022 PH RS 20.04.2022 Issue Revision Description

Drawn Check Date









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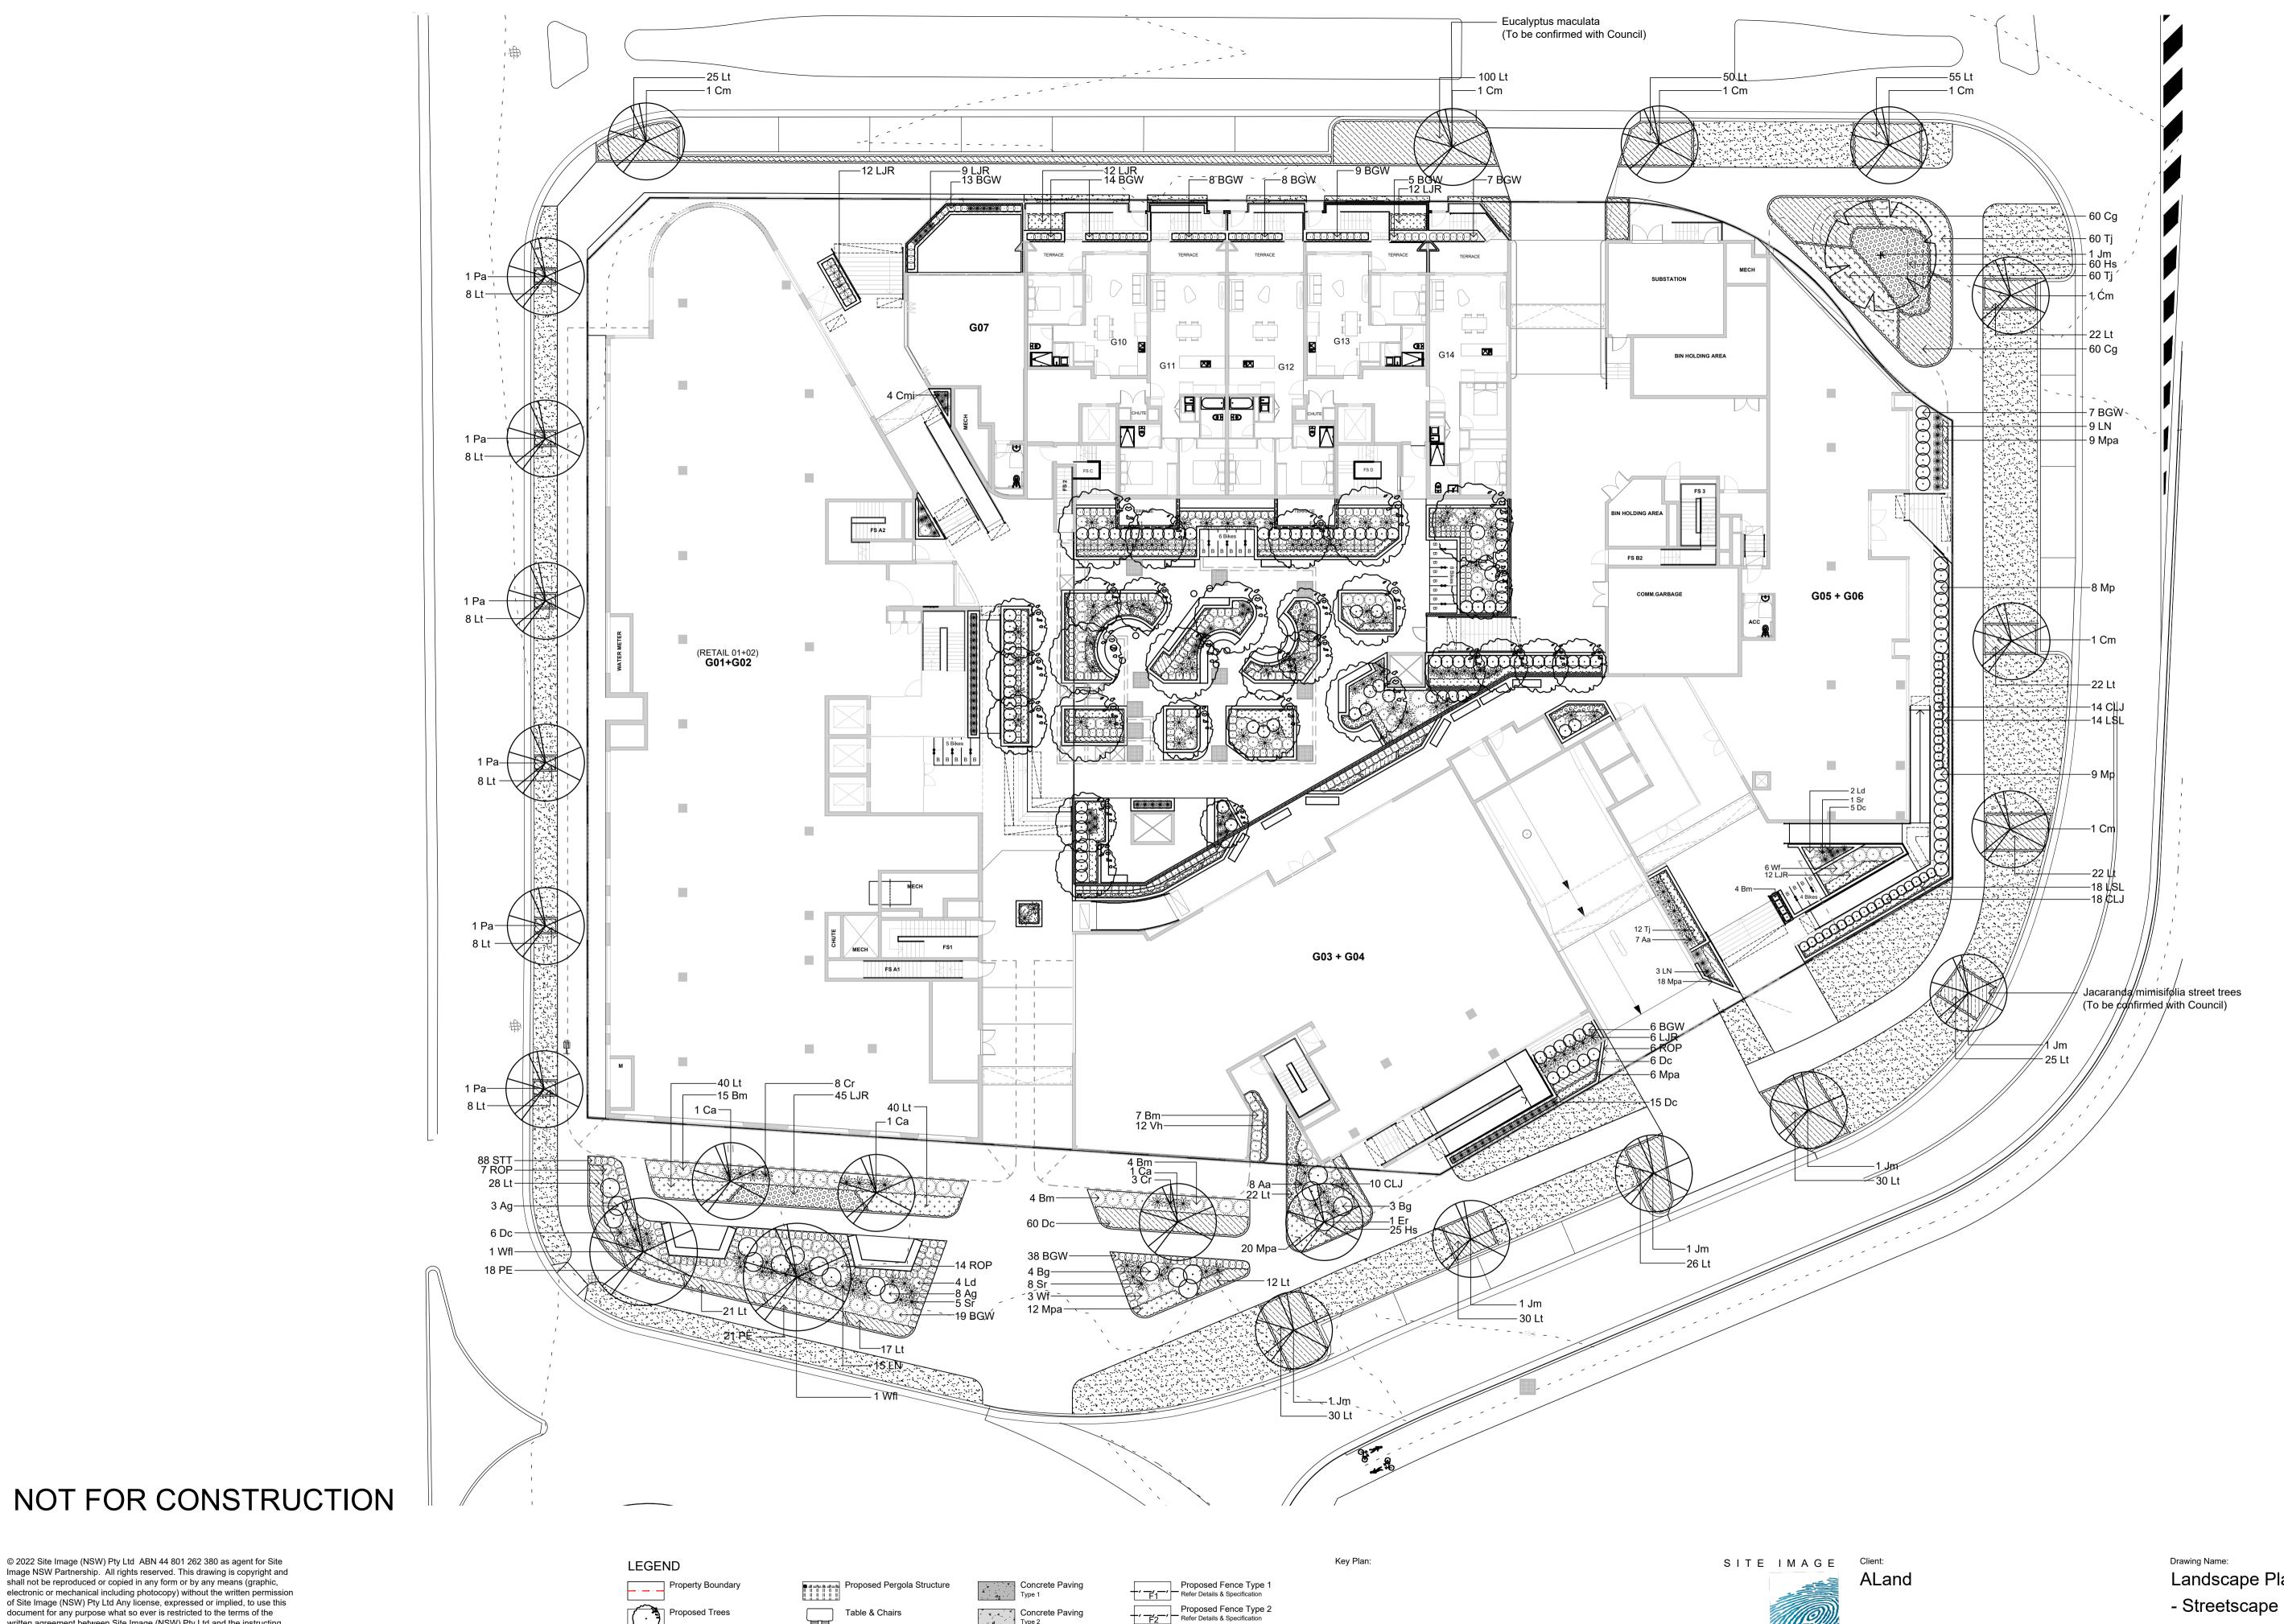
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Drawing Name: Landscape Plan - Building A Level 20 Roof Terrace

SECTION 4.55 Scale: 1:100 @ A1

Drawing Number: 103 E SS22-4883



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Levels updated

Issue Revision Description

B S4.55

A \$4.55

PH RS 13.09.2022 Council RFI updated planting labels, soil depth PH RS 07.09.2022 OSD, Pits Location updated PH RS 01.06.2022 PH RS 18.05.2022 PH RS 20.04.2022

Drawn Check Date

Proposed Shrub and Accent Concrete Bench Seating Proposed Massed Grasses and Groundcovers BBQ Facilities Proposed Turf Sun Loungers

Concrete Unit Paving
Refer Arch. Drawings Concrete Unit Paving
Refer Arch. Drawings Decomposed Granite

Proposed Fence Type 2
Refer Details & Specification Proposed Fence Type 3
Refer Details & Specification Proposed Raised Planter Bed Proposed Soil Depth Proposed Floor level Proposed Top of Bench level Proposed Top of Wall level Proposed Top of Fence level

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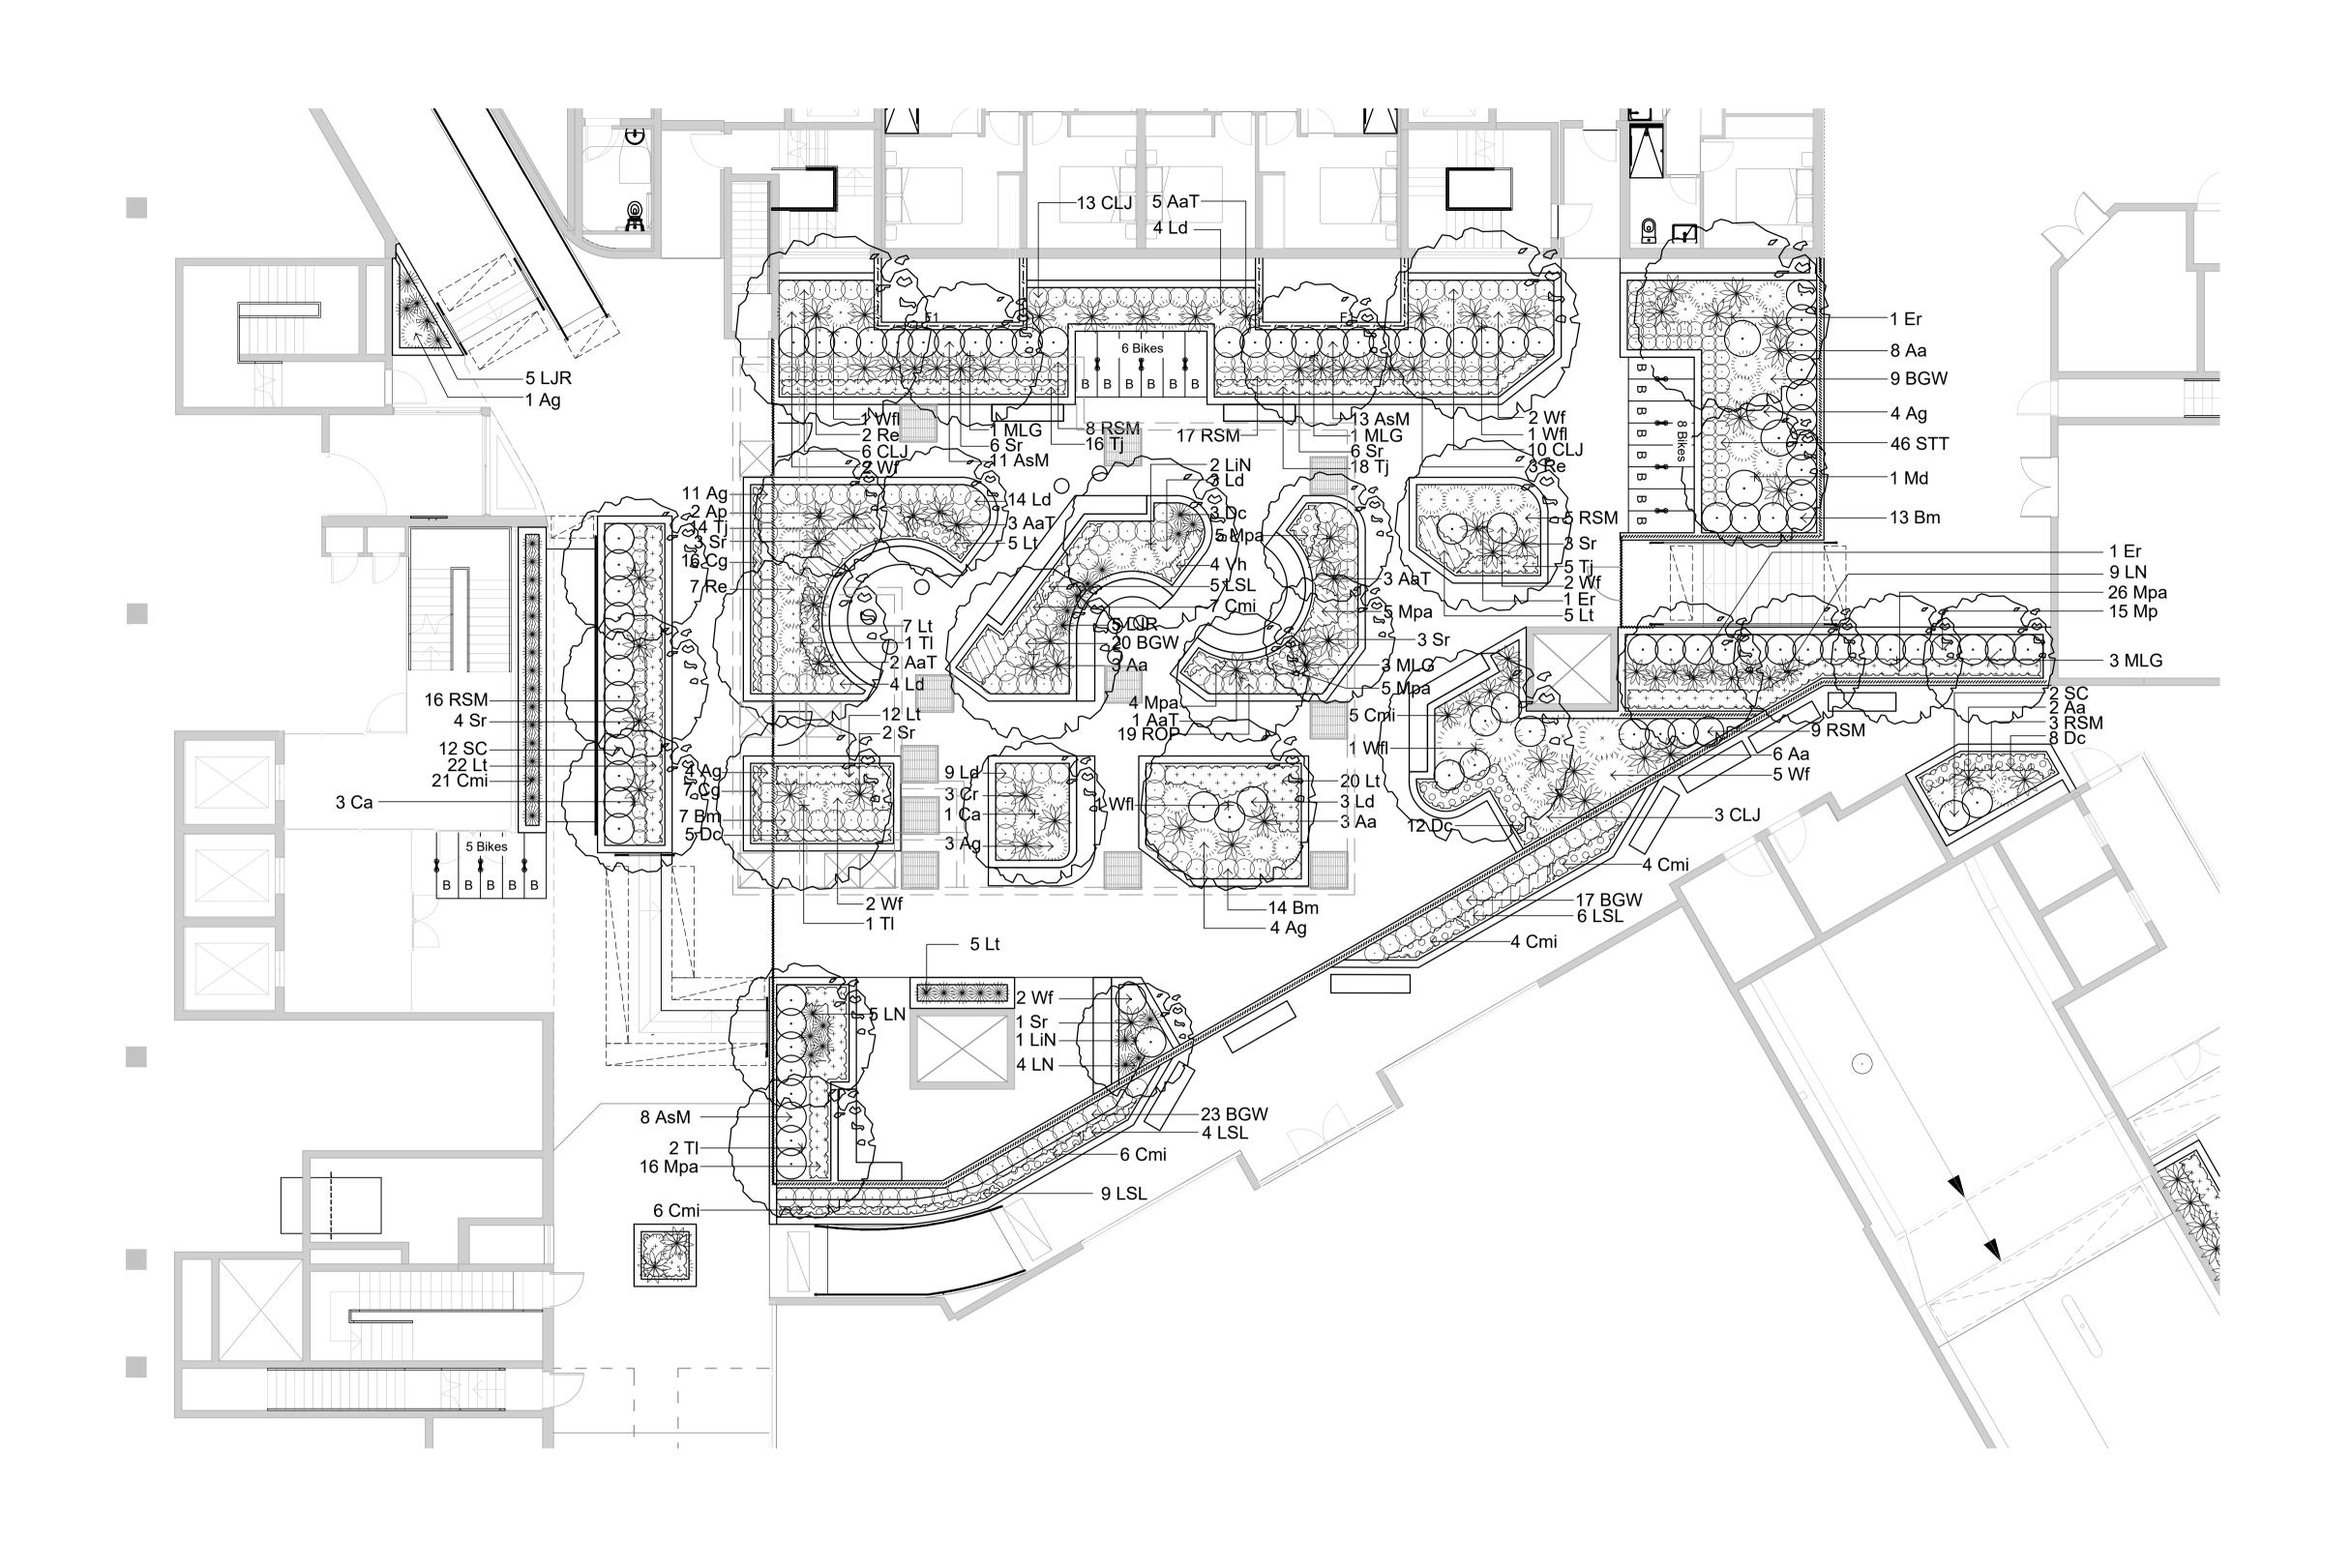
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Landscape Planting Plan

SECTION 4.55 Scale: 1:200 @ A1

Drawing Number: SS22-4883 401.1 E



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Proposed Pergola Structure Table & Chairs Proposed Shrub and Accent Concrete Bench Seating BBQ Facilities Proposed Massed Grasses and Groundcovers Sun Loungers Proposed Turf

LEGEND

Concrete Paving Concrete Paving
Type 2 Concrete Unit Paving
Refer Arch. Drawings Concrete Unit Paving
Refer Arch. Drawings Decomposed Granite

Proposed Fence Type 1
Refer Details & Specification Proposed Fence Type 2 Refer Details & Specification Proposed Fence Type 3
Refer Details & Specification Proposed Raised Planter Bed Proposed Soil Depth Proposed Floor level
Proposed Top of Bench level
Proposed Top of Wall level Proposed Top of Fence level






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Landscape Planting Plan - Ground Floor Central Courtyard

SECTION 4.55 Scale: 1:100 @ A1 Drawing Number: 401 E

SS22-4883

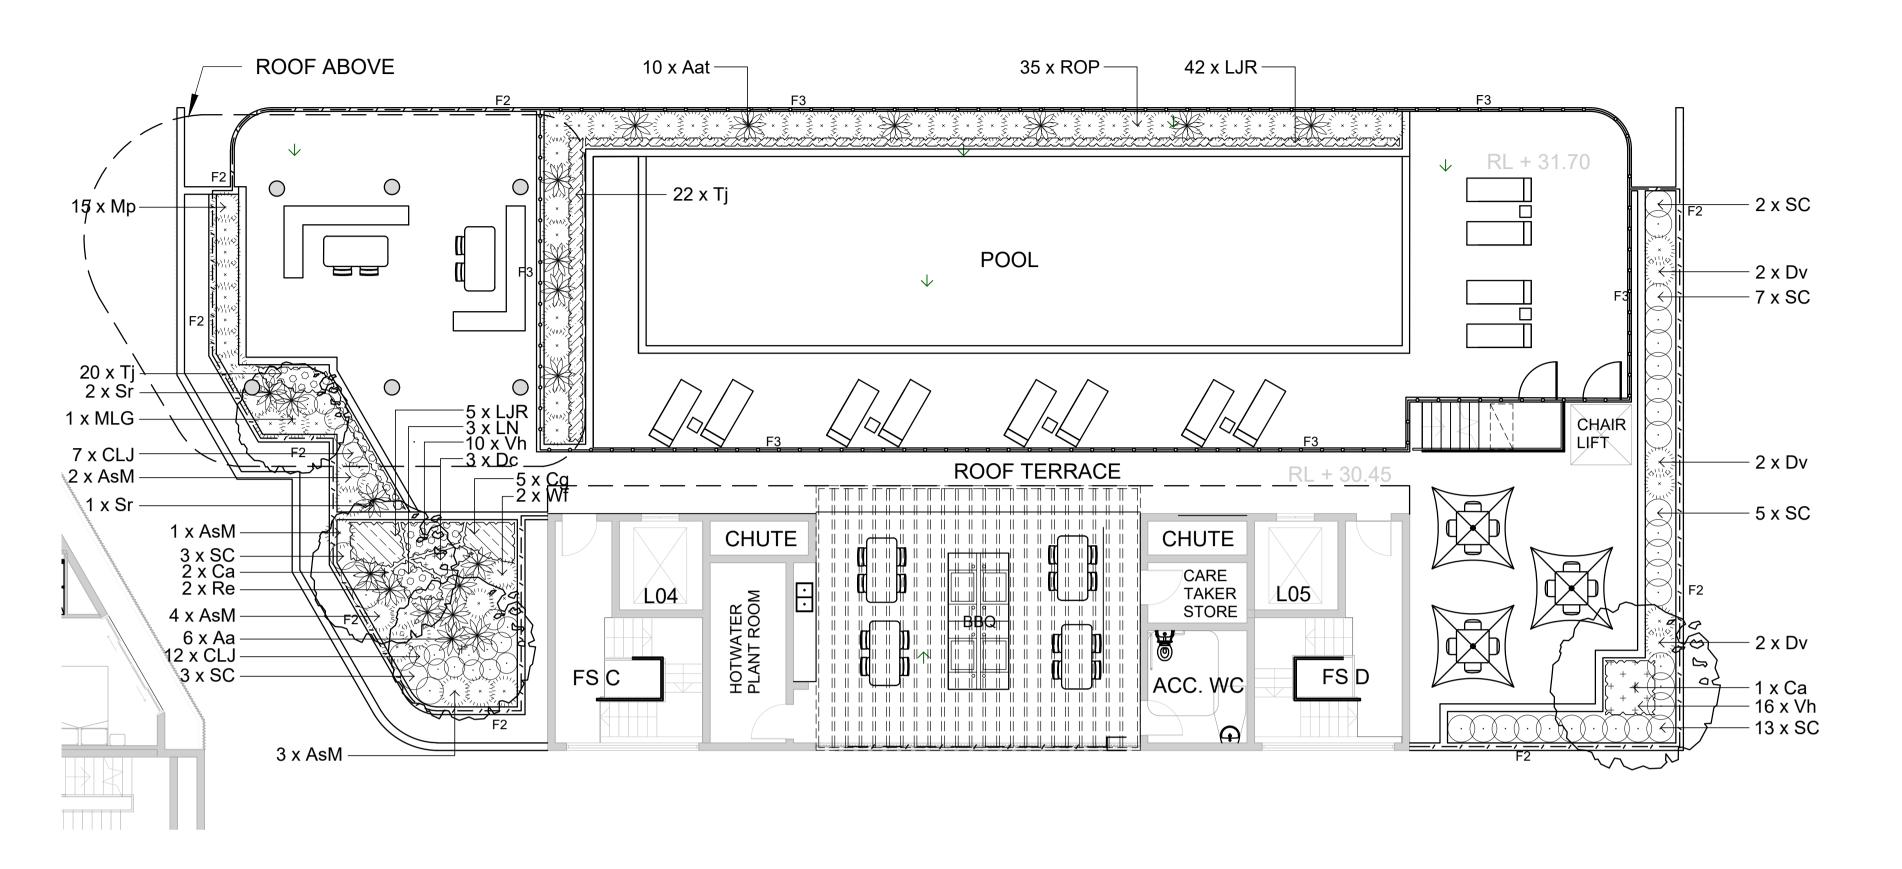



Building C Level 4 Roof Terrace


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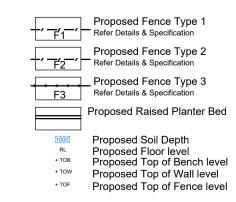
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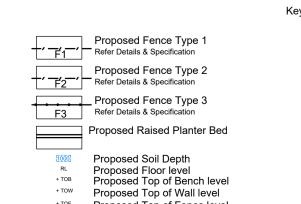
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3 x Lt —

15 x LJR -13 x Wf -

23 x Lt -14 x BGW-

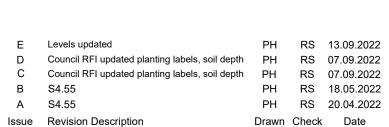4 x Aa

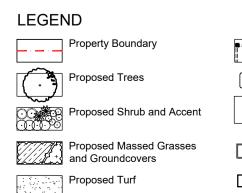7 x Vt

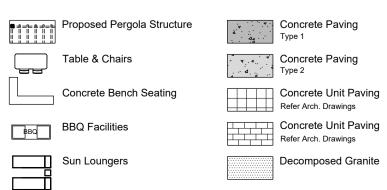AC PLANT

L-/--/

TRAFFICABLE

FS B2

WATER PLANT ROOM


ACC. WC

STORE ROOM

10

**ADAPTABLE** 

FS B2

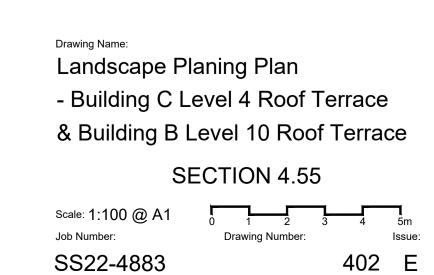

−27 x Vt

−5 x MLG

−75 x Lt

TURF

−19 x SC

-26 x Dc

–10 x Tj

-3 x Wf

# 10 x ROP -10 x Lt -4 x Dc 6 x Ag −6 x Aat 14 x Mpa -11 x LJR 9 x Lt -10 x Lt –13 x BGW 4 x BGW -10 x CLJ 10 x CLJ −10 x Lt −3 x Sr 8 x Bm −6 х Мра 14 x Tj −3 x Dv −1 x Aa 12 x LSL 3 x Aat 10 x Lt 1 x Md −1 х Ар −10 x BGW −10 x ROP 6 x Ag -16 x Dc 9 x RSM −2 x Ld −1 x Wf 16 x Dc $0 0 0 7 \times LJR - 1$ −2 x Aa 2 x Sr FS A2 10 x ROP 47 x Mp -7 x LN-−9 x Cmi -12 x Dc -3 x Bm 6 x Ld--3 x Dv 15 x Cg · 3 x STT · -4 x Aat 15 x ROP--4 x LJR -2 x Ap -9 x Vm 1 x Ca 6 x Lt – 3 x Cr 6 x Bm 9 x Mp 13 x LSL TURF 4 x Bg 4 x Lt-2 x Vt 13 x Tj 7 x Bm 12 x Dc 9 x LN 8 x B**m** 3 x Ag 1 x Ca 4 x Re 4 x Vt 12 x BGW 2 x MLG 3 x Re -12 x ROP ACC wc -20 x Hs -16 x Lt 5 x Wf--7 x Bm 2 x Ca-−9 x Aa −10 x Mp 4 x Cmi-4 x CLJ-−5 x CLJ Building A Level 19 Roof Terrace

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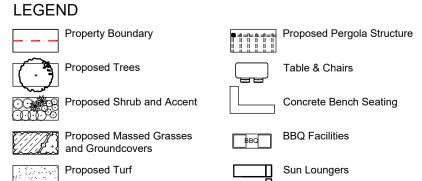
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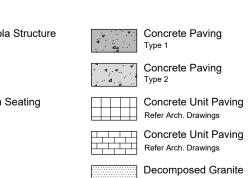
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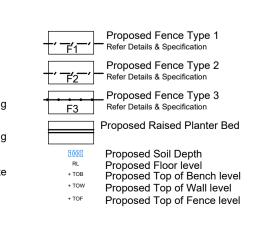
Levels updated PH RS 13.09.2022 Council RFI updated planting labels, soil depth PH RS 07.09.2022 C Council RFI updated planting labels, soil depth PH RS 07.09.2022 B S4.55 PH RS 18.05.2022 A S4.55 PH RS 20.04.2022

Issue Revision Description

Drawn Check Date













Landscape Planting Plan - Building A Level 20 Roof Terrace

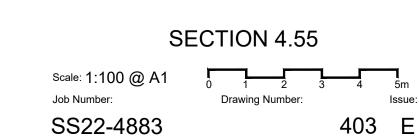

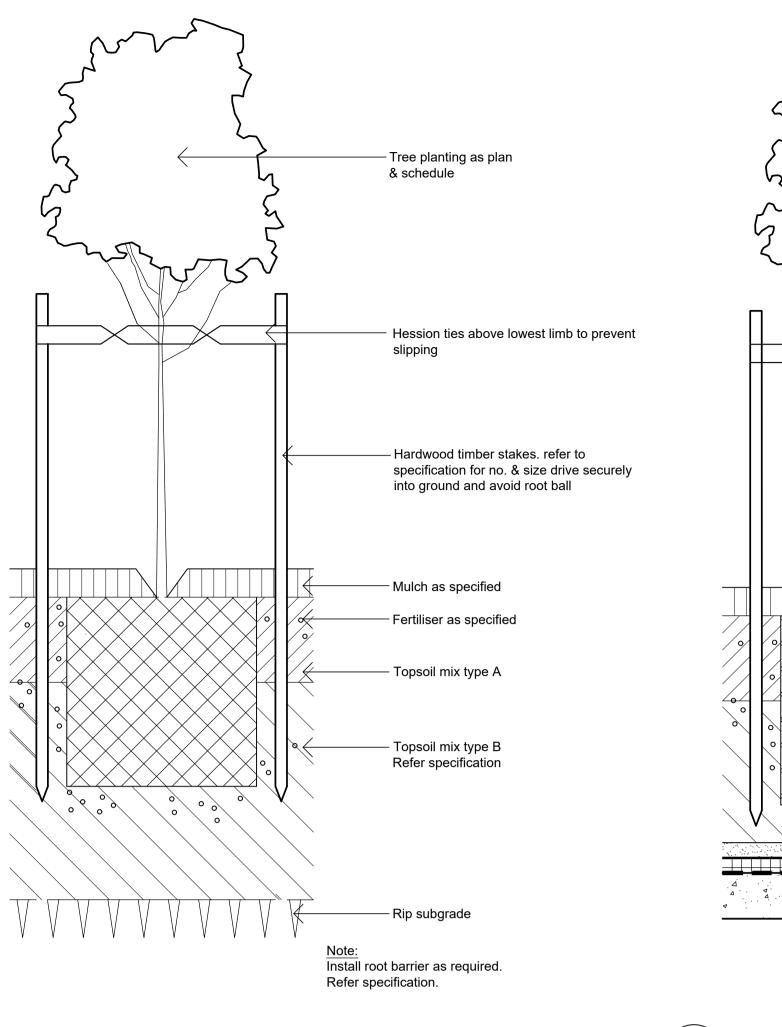

Waterproof membrane. Refer Architects drawings. 2 DETAIL - 75-200L TREE PLANTING ON SLAB

# Shrub, accent & groundcover planting refer plan & schedule Mulch as specified Fertilise Refer specification Soil mix type A Soil mix type B Coarse washed river sand Drainage cell & geotextile filter cloth as specified Suspended concrete slab by others. Screed surface falls to Hydraulic Engineer's details.

Waterproof membrane. Refer Architects drawings

LEGEND

5 \ Detail Turf on Even Grade

# **SPECIFICATION GENERAL NOTES**

All plans and details included in the project documents shall be read in conjunction with this specification. All structural and civil works components of the landscape design shall be referenced to engineers' details and specifications. Read this specification in conjunction with the plant and materials schedules on the drawings. If in doubt about any detail or if conflicts are found in the documents, seek advice.

### **Workmanship and Materials**

The whole of the landscape works shall be carried out by a competent, trained and qualified landscape contractor who is experienced in horticultural practices, landscape construction and planting techniques. The landscape contractor shall hold a current Building Contractors License and/or be a financial member of LNA Landscape Association NSW & ACT or equivalent organisations in

# **HARDWORKS**

### Furniture, Handrails, Balustrades

Supply and install the scheduled items in accordance with the manufacturer's recommendations, as detailed and in the locations shown on plan. Provide all footings and fixings required for the items to be stable and in accordance with applicable codes and standards.

### Garden Walls, Fences, Steps, TGSI and Edging

Construct garden walls, fences, steps, TGSI and edging as shown on plan, as detailed and of the material scheduled. Provide footings, step nosings, tactile surfaces to comply with standards and applicable legislation. Refer to engineer's details for structural retaining walls, heavy duty slabs, concrete stairs, concrete strength, reinforcing and joint placement.

### Fence on ground floor

Fence Type F1: Screen (600mm wall + 900mm Slatting Panel)

Location: Ground floor (Refer Ground floor Plan) • Screen Supplier: equal to Superior Screens (phone: 1300 766

- 799) Maxislat MS-20 55 x 7.5mm slats
- Colour: Dulux Colourbond 'Monument'
- Panel Size: 600 x 1200mm max,
- Posts: 50mm square
- Fencing contractor is to prepare shop drawings & subject & adjust until approved as AFC.

### Fence on Level 4 & Level 10 terraces

Footings vary as scheduled below and appropriate to the situation at any point along the fence length. Mass concrete to engineer's details. Core drilled and filled with non-shrink mortar around post. Side fixed with 12mm Chemset masonry anchors.

### Erect posts vertically. Set heights to follow the top of wall lines as appropriate. Ensure rails are installed horizontally.

Gates are to match the fence in terms of appearance, materials, finish, colour, with suitable and appropriate hardware including at least two (2) stainless steel hinges to ensure smooth operation, childproof locks, mortise locks and lever handles as required for secure functionality at each location on plan. Al fittings to be 316 stainless steel.

### Supply and install the following fence/gate types:

### Fence Type F2: Palisade Fence Medium Security

- Location: As shown on the drawings, generally at or near parapet
- Supplier / Product: Equal to ARC, Ambassador Material: Galvanised steel
- Finish: Powder-coat gloss
- Colour: All members and fixings Black
- Panel Height: 1200mm above top of wall or paving level • Pickets: 25 x 25 x 1.2 @ 140 centres, through rails, black
- Rails: 40 x 40 x 1.6, 40 x 40 rail flange fixing to posts with Tek
- Posts: 65 x 65 x 2.0 @ 2400 centres, 2700 in ground height, black capped
- Gates: To match fence in appearance with drop bolts, lugs, chain, striker, ball bearing hinges
- Gate Width: Nominally 900 wide • Footings: Various: Mass concrete to engineer's details, core
- drilled into concrete, side fixed bolted to wall
- All subject to workshop drawing details

### Fence Type F3: Glass Pool Fence

- Location: As shown on the drawings, generally at the pool
- Supplier / Product: Bespoke
- Material: 10mm toughened glass (min)
- Finish: Fittings: 316 marine grade stainless steel Colour: Clear
- Panel Height x length: 1300 (1200mm above decking level) x 1200 lona
- Gate: To match fence in appearance complete with safety latch, hinges and be self-closing and latching
- Gate Width: Nominally 900 wide • Fixings: Proprietary stainless steel brackets concealed below decking boards to detail

All subject to workshop drawing details

Refer Architectural drawings for detail

### **Timber Decking**

Refer Architectural drawings for detail

# • Loaction: As shown on plans and associated with path, stairs

- Manufacturer: Tactile Systems Australia TSA
- Material: 316 stainless steel
- Type: Warm (Studs) TSA.STEEL-TAC SMOOTH SERIES Silver, Black.
- Installation: Set out the pattern of studs and / or bars and drill holes with diamond core bit. Epoxy glue the TGSI stems into the holes. All in accordance with the manufacturers instructions.

### Manufacturer: Christie Parksafe

- Modular Triple Installation Kit with 2xCCQ Gas
- Bench Height: 900mm
- Bench Depth: 750mm
- Bench Length: 2035mm

### **Continuous, Unit and Loose Pavement** Install the scheduled material pavement to the locations shown on

plan. Ensure that all subgrade/subsurface works are complete prior to commencing paving. Confer with the engineer to ensure the structural integrity of the subgrade. Ensure that the base course under paved surfaces is a continuous plane offering a constant depth of bedding material not exceeding 50mm.

### **SOFTWORKS**

### Topsoil

Import topsoil for the garden and turf areas, unless the topsoil can be provided from material recovered from the site, as recommended in the soil testing results. Spread the topsoil on the prepared subsoil and grade evenly, compact lightly and uniformly in 150mm layers. Avoid differential subsidence and excess compaction and produce a finished topsoil surface which has the following characteristics:

- Finished to design levels, allowing for mulch or turf, which is to finish flush with adjoining hard surfaces such as paths and
- Smooth and free from inorganic matter, stones or clods of soil;
- Graded to drain freely, without ponding, to catchment and/or
- sub-soil drains;
- Graded evenly to adjoining surfaces; and
- Ready for planting.

### Compost

Provide, in accordance with AS 4454, well rotted vegetative material or animal manure, free from harmful chemicals, inorganic matter, grass, weeds and the reproductive parts of unwanted

duration of the contract Defects Liability Period. Unless contracted otherwise, the Landscape Contractor shall maintain the contract areas by the implementation of industry accepted horticultural practices for 52 weeks from Practical Completion of the works. The landscape maintenance works shall include, but not be limited to: Replacing failed plants:

Provide proprietary fertilisers, delivered to the site in sealed

containers marked to show manufacturer or vendor, weight,

fertiliser type, N:P:K ratio, recommended uses, application rates

and safety procedures. Apply appropriate fertiliser suited to the

Supply plants in accordance with the landscape design drawings

• Large healthy root systems, with no evidence of root curl,

Vigorous, well established, free from disease and pests, of good

Hardened off, not soft or forced, and suitable for planting in the

• Trees. unless required to be multi-stemmed, shall have a single

• Containers shall be free from weeds and of appropriate size in

Following excavation of the planting hole, place and spread 15gms

of wetting agent pre-mixed with one (1) litre of water. Place the

plant correctly orientated to north or for best presentation. Backfill

the planting holes with specified topsoil mixture. Lightly tamp and

water to eliminate air pockets. Ensure that the backfill soil is not

placed over the top of the root ball and that the root ball is not

higher than the soil in which it is planted. Apply fertiliser, as

Supply and install root control barriers to all new tree plantings

adjacent to walls, paths, kerbs and all service trenches, where

their proximity poses a threat to the stability of the built

infrastructure. Install in accordance with manufacturer's

Unless noted otherwise, mulch shall be approved proprietary

recycled wood fibre or pine bark material. Place mulch in all

garden beds to a depth of 75mm after all specified plants are

installed. Keep mulch clear of all plant stems and rake to an even

plane, flush with the surrounding surfaces evenly graded between

design surface levels. Over fill to allow mulch to settle to the

Stakes shall be durable hardwood, straight, free of knots and

twists, pointed at one end, in the following quantities and sizes for

The irrigation system shall be an automatic permanent system,

with an irrigation controller self operated via a soil moisture sensor.

The system shall be calibrated to deliver the optimum rate and

volume of water appropriate to the type of plants in the design. The

system shall be adjustable and fully serviceable. The layout of the

entire irrigation system shall focus on delivering the required

amount of water to maintain healthy and vigorous growth. The

irrigation system shall be such that, component theft, vandalism,

over-spray and wetting of paths shall be reduced to a minimum or

completely eliminated by the use of drip, pop-up sprinklers and judiciously placed fixed spray emitters. Generally do not use fine

mist emitters that provide a drifting mist that may wet paths and the

The Landscape Contractor shall rectify defects during installation

and that become apparent in the works under normal use for the

Implement and keep a maintenance log book recording when and

Semi-advanced plants (>75 lt): 2 off 50x50x 1800mm;

specified around the plants in the soil at the time of planting.

natural climatic conditions prevailing at the site in full sun, partial

and schedules, which have the following characteristics:

• Grown in final containers for not less than twelve weeks;

form consistent with the species/variety;

shade or full shade conditions;

relation to the specified plant size.

restriction or damage;

leading shoot; and

recommendations.

specified depth.

IRRIGATION

each of the various plant pot sizes:

Plants (>25 lt): 1 off 38 x 38 x 1200mm;

Advanced (>100 lt): 3 off 50 x 50 x 2400mm.

All proposed landscape areas shall be irrigated.

buildings unless specifically required by the design.

provenance of plants (indigenous or exotic) included in the design.

Pruning;

LANDSCAPE MAINTENANCE

- Insect and pest control; Fertilising;
- Maintaining and removing stakes and ties; Maintaining mulch;
- Mowing and top dressing;
- Irrigation and watering; Erosion control: and
- · Weeding and rubbish removal.

Maintenance Log Book

### what maintenance work has been undertaken and what materials, actions and decisions have been used, implemented and concluded to keep the landscape always looking its best. Enter data daily and review information every 2 weeks. Observe trends and develop a maintenance regime around seasonal and observed event occurrences.

### Maintenance Activities

During the defects maintenance period schedule the following activities to occur on a timely basis.

- Plant replacement Replace plants that have failed to mature, die or are damaged. Replacement plants shall be in a similar size and quality and identical species or variety to the plant that has failed. Replacement of plants shall be at the cost of the landscape contractor unless advised otherwise. If the cause of the failure is due to a controllable situation then correct the situation prior to replacing plants. Observe and replace failed plants within 2 weeks of observation.
- **Pruning** Prune dead wood, broken limbs, dead or infected foliage and as needed to develop strong, healthy plants to achieve the shape and form expected of the plant type. Observe daily and prune plants on a needs basis
- Insect, disease and pest control Avoid spraying:
- if ever possible;
- in wet weather or if wet weather is imminent;
- if target plants are still wet after rain;
- in windy weather; and
- if non-target species are too close. Immediately report to the Project Manager any evidence of intensive weed infestation, insect attack or disease amongst plant material. Submit all proposals to apply chemicals and obtain approval before starting this work. When approved,

spray with herbicide, insecticide, fungicide as appropriate in

accordance with the manufacturers' recommendations. Observe

daily and act as necessary to control any infestation or disease.

- Record in the logbook all relevant details of spraying activities
- Product brand / manufacturer's name,
- Chemical / product name, Chemical contents.
- Application quantity and rate,
- Date of application and location,
- Results of application, and
- Use approval authority. **Fertilising** - Fertilise gardens with a proprietary slow release
- fertiliser applied in accordance with the manufacturer's directions and recommendations. Apply 6-12 monthly. Record in the logbook all relevant details of fertilising including:
- Product brand / manufacturer's name,
- Fertiliser / product name, Application quantity and rate, and
- Date of application and location.

any damage as soon as possible.

removal of weeds is essential.

- Stakes and ties Adjust and replace as required to ensure plants remain correctly staked. Remove those not required at the end of the planting establishment period (Defects Liability Period). Inspect and act at least every 2 weeks.
- Maintaining mulch Maintain the surface in a clean, tidy and weed free condition and reinstate the mulch as necessary to ensure correct depth as specified. Observe weekly and replenish mulch as required.
- Mowing and top dressing Mow the turf to maintain a grass height of between 30-50mm. Do not remove more than one third of the grass height at any one time. Remove grass clippings from the site after each mowing. Top dress to a maximum of 10mm to fill depressions and hollows in the surface. Mow weekly/fortnightly in warmer months. Mow monthly or as required in cooler months. Top dress at
- approximately 6 monthly intervals. • Irrigation and watering - Maintain the irrigation system to sure that each individual plant receives the required amount of wate to maintain healthy and vigorous growth. Adjust and calibrate as required. Provide additional watering, if necessary but inspect
- irrigation weekly and make repairs as necessary. • Erosion control - Where necessary, maintain the erosion control fabric in a tidy and weed free condition and reinstate as necessary to ensure control measures are effective where deemed necessary. Inspect every 2 weeks and act to repair
- Weeding and rubbish removal During the plant establishment period remove by hand, rubbish and weed growth that may occur or re-occur throughout all planted, mulched and paved areas. The contractor shall target weeds that are capable of producing a major infestation of unwanted plants by seed distribution. Whenever possible, time weed removal to precede flowering and seed set. Constant observation and

NOT FOR CONSTRUCTION

\ DETAIL - SHRUB, ACCENT & GROUNDCOVER PLANTING ON SLAB

DETAIL - 75-200L TREE PLANTING ON GRADE


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The contractor shall check and verify all work on site (including work by others) before commencing the landscape installation. Any discrepancies are to be reported to the Project Manager or Landscape Architect prior to commencing work. Do not scale this drawing. Any required dimensions not shown shall be referred to the Landscape Architect for confirmation.

Levels updated PH RS 13.09.2022 Council RFI updated planting labels, soil depth PH RS 07.09.2022 PH RS 01.06.2022 S4 55 B S4.55 PH RS 18.05.2022 A S4.55 PH RS 20.04.2022 Drawn Check Date Issue Revision Description



Tree planting as plan

Hession ties above lowest limb to prevent

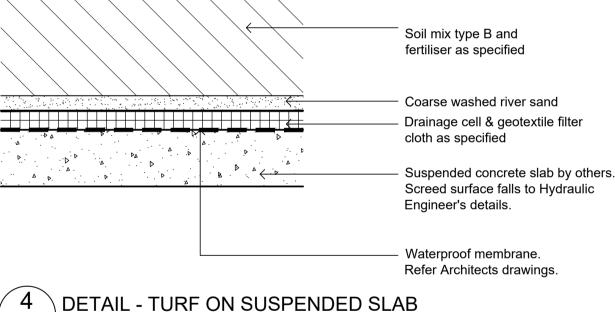Hardwood timber stakes. refer to

into ground and avoid root ball

Mulch as specified

Fertiliser as specified

- Topsoil mix type A

Topsoil mix type B

Refer specification

cloth as specified.

Engineer's details.

Coarse washed river sand.


Drainage cell & geotextile filter

Suspended concrete slab by others.

Screed surface falls to Hydraulic

specification for no. & size drive securely

& schedule

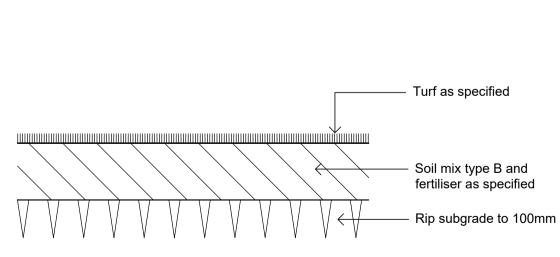

PRECAST UNIT PAVERS ON SUSPENDED SLAB **SCALE 1:10** 

> SITE IMAGE Landscape Architects

> > Level 1, 3-5 Baptist Street

Fax: (61 2) 9698 2877

www.siteimage.com.au

Precast unit paving with

mortar joints as specified

Waterproofing & drainage

Suspended concrete slab

25mm mortar bed.

by others.

228 Pitt Street Merrylands Redfern NSW 2016 NSW 2160 Tel: (61 2) 8332 5600

**ALand** 

Landscape Details

& Landscape Specification

SECTION 4.55

Drawing Number:

SS22-4883

Scale: As Shown Job Number:

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